



PIPE COVER DETAIL
SCALE: NTS

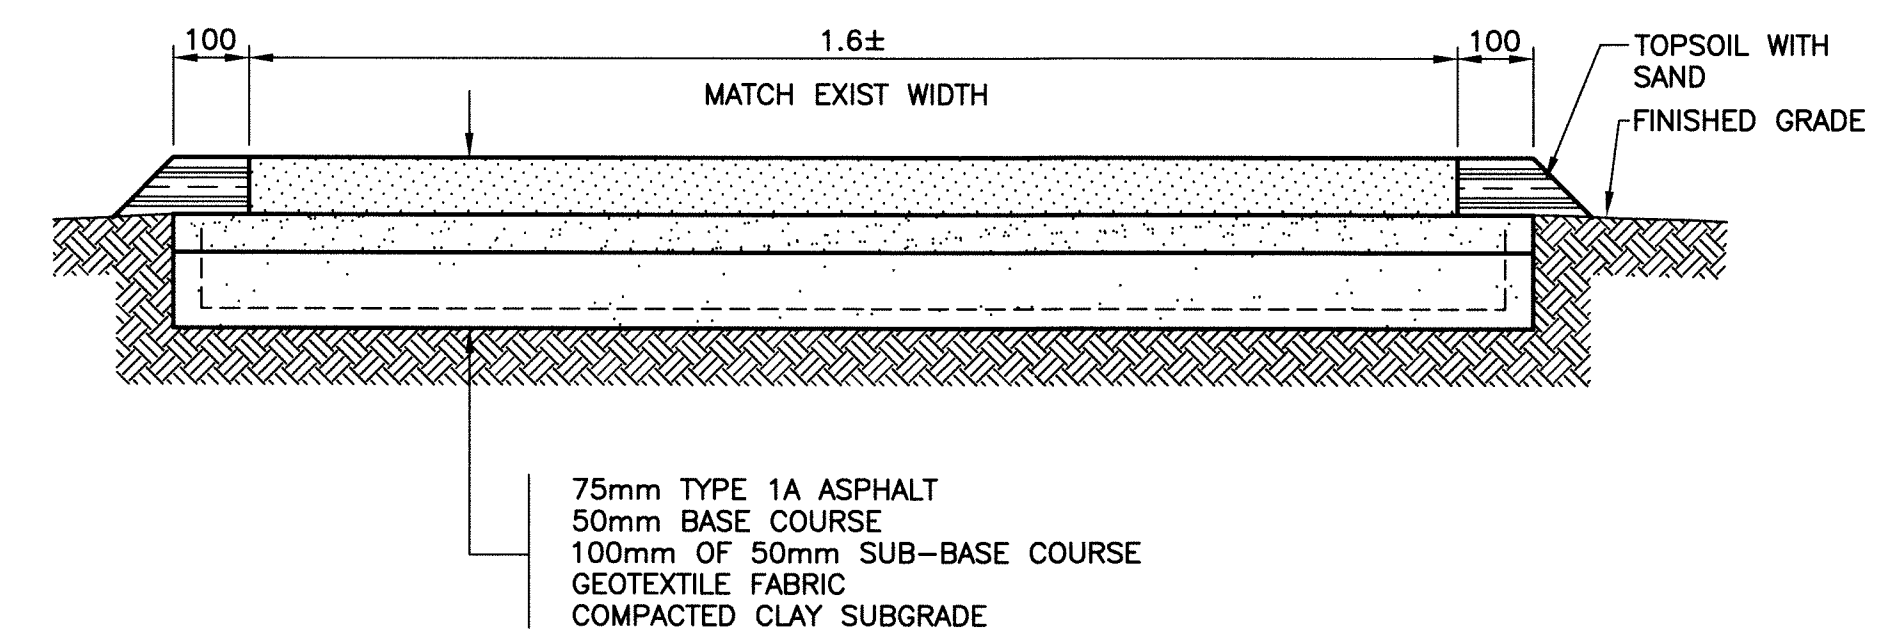


ASPHALT SIDEWALK DETAIL
SCALE: NTS

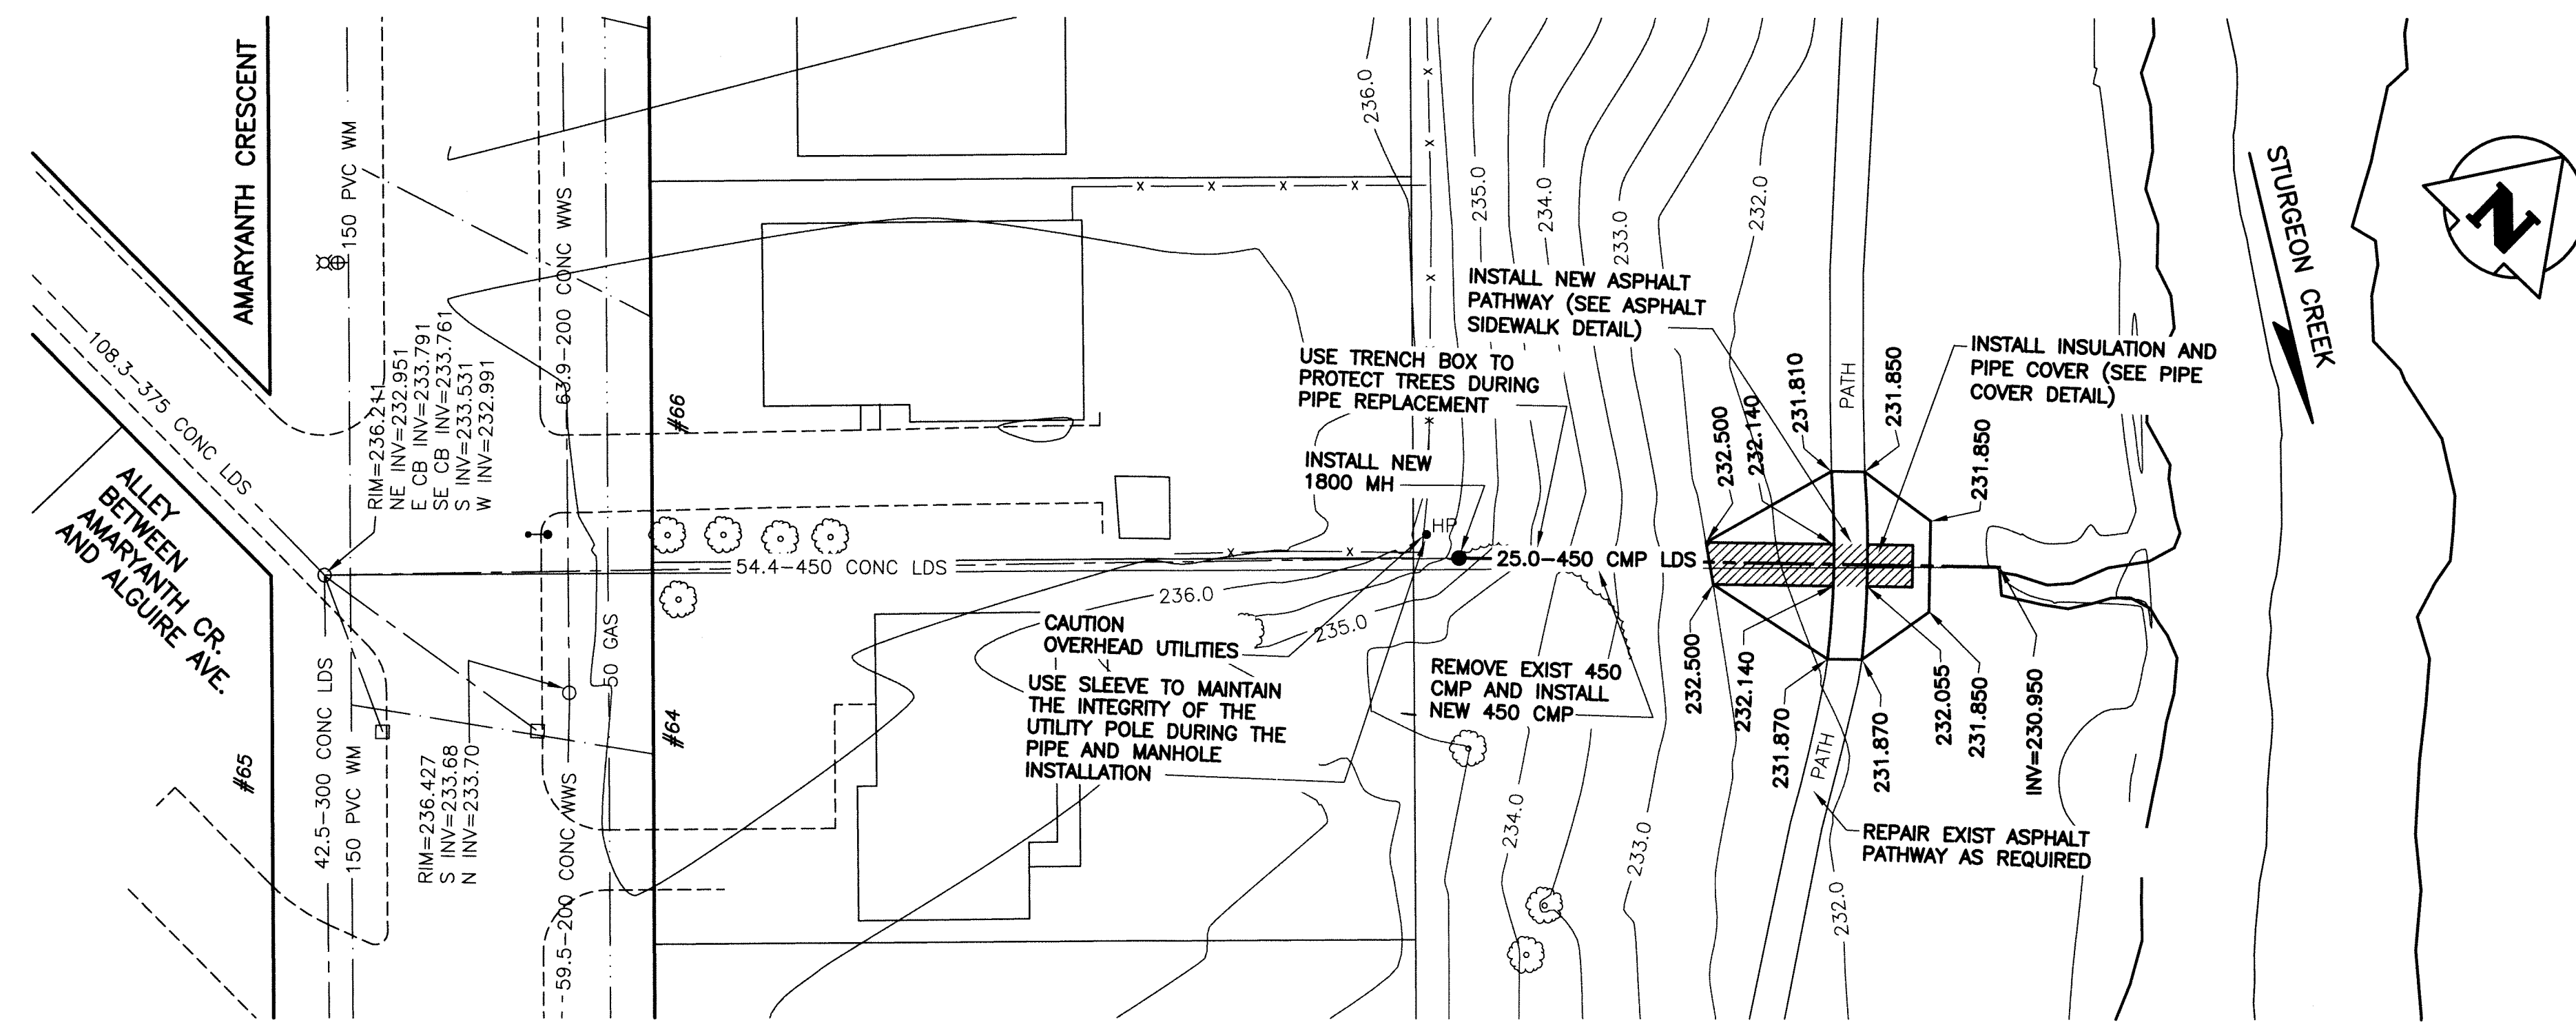

PROPERTY LIMITS DELINEATION
DELINEATION OF PROPERTY LIMITS AS SHOWN ON THIS DWG DOES NOT REPRESENT A "LEGAL SURVEY". KGS GROUP MAKES NO REPRESENTATION OR WARRANTY AS TO THE ACCURACY OF PROPERTY LIMITS DELINEATED ON THIS DWG, NOR ON THE DIMENSIONAL ACCURACY OF DWG FEATURES RELATIVE TO THOSE PROPERTY LIMITS.

- NOTE:
- NO STOCK PILING MATERIALS, ALL EXCAVATED MATERIAL TO BE MOVED OFF SITE.
 - ACCESS TO SITE TO BE DEVELOPED BY THE CONTRACTOR


METRIC
WHOLE NUMBERS INDICATE MILLIMETRES
DECIMALIZED NUMBERS INDICATE METRES

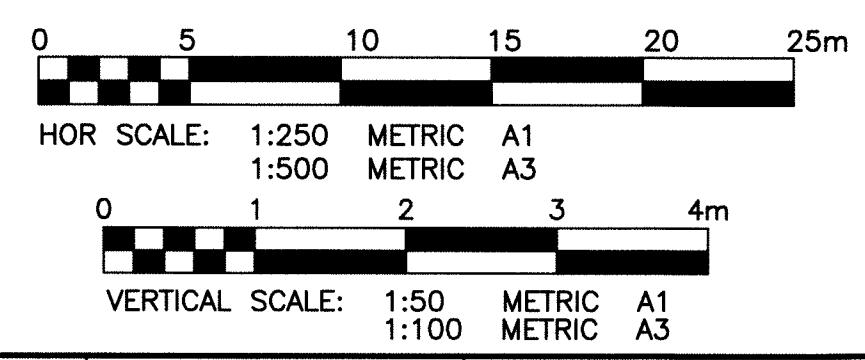

300_LDS	LAND DRAINAGE SEWER	300_LDS							
250_WWS	WASTE WATER SEWER	250_WWS							
	GAS								
	HYDRO								
	M.T.S.								
150_WM	WATERMAIN	150_WM							
	HYDRANT								
	VALVE								
	MANHOLE								
	CATCH BASIN								
	CURB INLET								
	POLES								
EXISTING	LEGEND-PLAN	PROPOSED	EXISTING	LEGEND-PLAN	PROPOSED	EXISTING	LEGEND-PROFILE	PROPOSED	

LOCATION APPROVED UNDERGROUND STRUCTURES
SUPV. U/G STRUCTURES COMMITTEE DATE
NOTE: LOCATION OF UNDERGROUND STRUCTURES AS SHOWN ARE BASED ON THE BEST INFORMATION AVAILABLE BUT NO GUARANTEE IS GIVEN THAT ALL EXISTING UTILITIES ARE SHOWN OR THAT THE GIVEN LOCATIONS ARE EXACT. CONFIRMATION OF EXISTENCE AND EXACT LOCATION OF ALL SERVICES MUST BE OBTAINED FROM THE INDIVIDUAL UTILITIES BEFORE PROCEEDING WITH CONSTRUCTION.

B.M. KGS BASE ELEV. -	DWGS BASED ON C.S.R.S. NAD 83 SYSTEM, UTM GRID
DESIGNED BY RBO	CHECKED BY Agh
DRAWN BY DMW	APPROVED BY
HOR. SCALE: 1:250	RELEASED FOR CONSTRUCTION:
VERTICAL: 1:50	DATE
ISSUED FOR TENDER 13/01/04	DATE 12/12/20
NO. REVISIONS	DATE

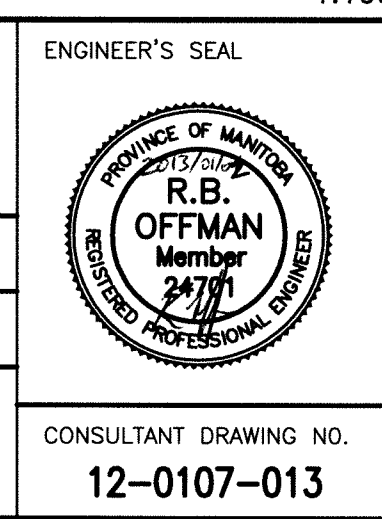

THE CITY OF WINNIPEG WATER AND WASTE DEPARTMENT
PROJECT TITLE: 2013 OUTFALL RENEWAL/REHABILITATION PROGRAM
AMARYNTH CRESCENT OUTFALL (ST-12) PLAN AND PROFILE

SHEET 01 OF 05
COMPUTER FILE NAME: 12-0107-013
CITY DRAWING NUMBER: LD-7016

CONSULTANT DRAWING NO. 12-0107-013

File Path: P:\Projects\2012\12-0107-013\Doc\Control\Tobelaused\DWG\12-0107-013_LD-7016-Rev.0.dwg - Tab: LD-7016 Plotted By: DBerche 13/01/02 [Wed 4:25pm] Plot Scale: 1:1